

RETAINING WALL SECTION

N.T.S.

1.2 m HIGH TYPE III SAFETY FENCE (CHAINLINK).
SEE HRM STANDARD DETAIL HRM42.

STONE STRONG
RETAINING WALL

LOT

1.1 m
MAX

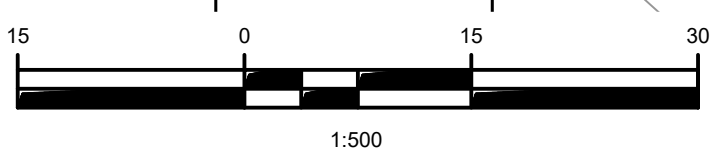
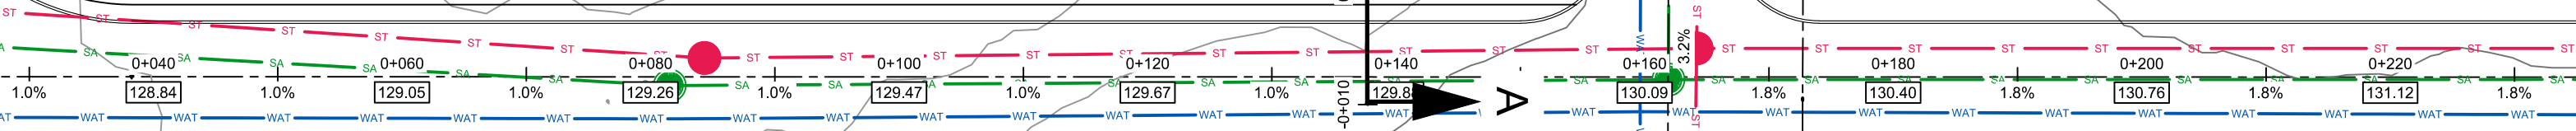
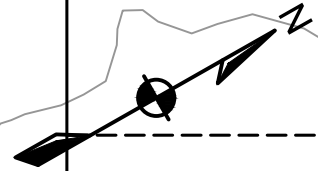
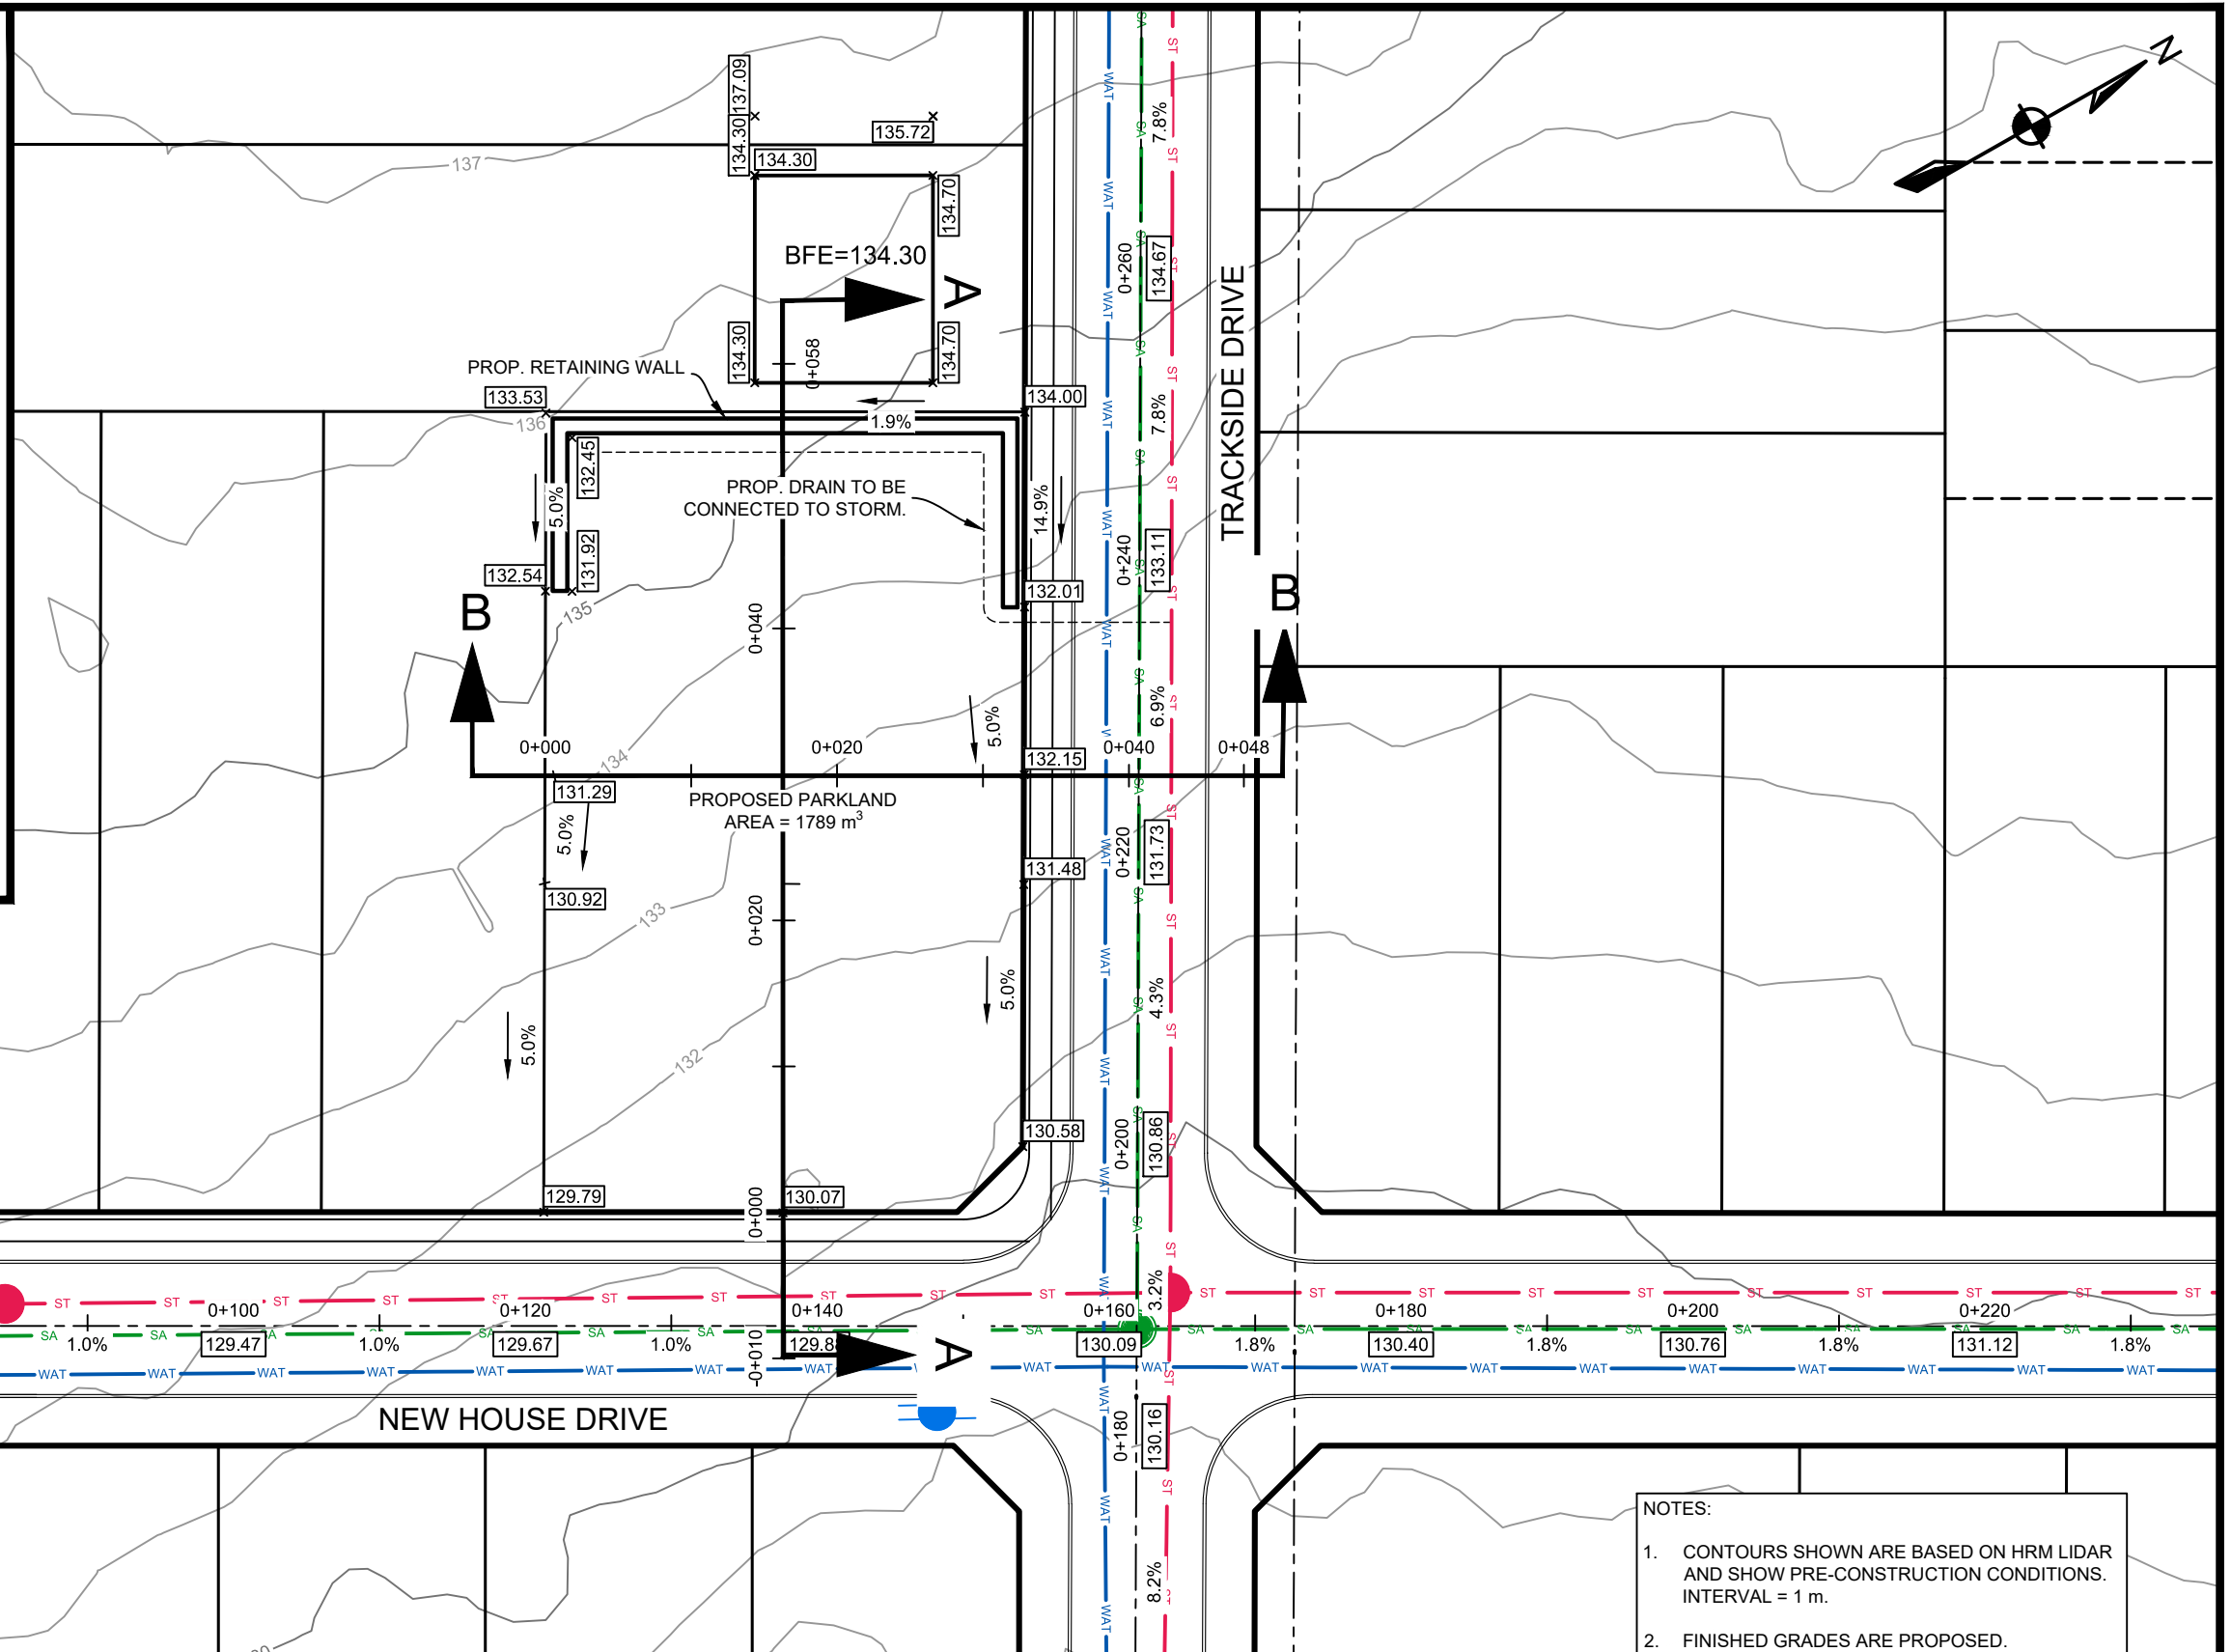
PARK

25 mm CLEAR STONE
DRAINAGE TRENCH LINED
WITH FILTER FABRIC

0.4 m MIN.

150 mm PVC DR35
PERFORATED PIPE @ 1% MIN.

MIN 225mm THICK 35mm
COMPACTED ROCK OR
LEAN CONCRETE



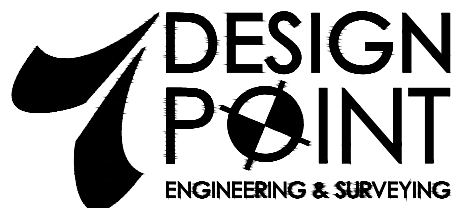
- NOTES:
- CONTOURS SHOWN ARE BASED ON HRM LIDAR AND SHOW PRE-CONSTRUCTION CONDITIONS. INTERVAL = 1 m.
 - FINISHED GRADES ARE PROPOSED.

CONSULTANT

CLIENT

PROJECT DESCRIPTION

SHEET DESCRIPTION



BERRY HILLS PHASE 8

PARK GRADING DETAILS
& PLAN SECTION A-A & B-B

MIDDLE SACKVILLE, NOVA SCOTIA

Engineer

Drawn

G. WOODFORD

E.E.H.

Scale

Date

1:500

Dec. 18, 2019

Project No.

Drawing No.

15-082

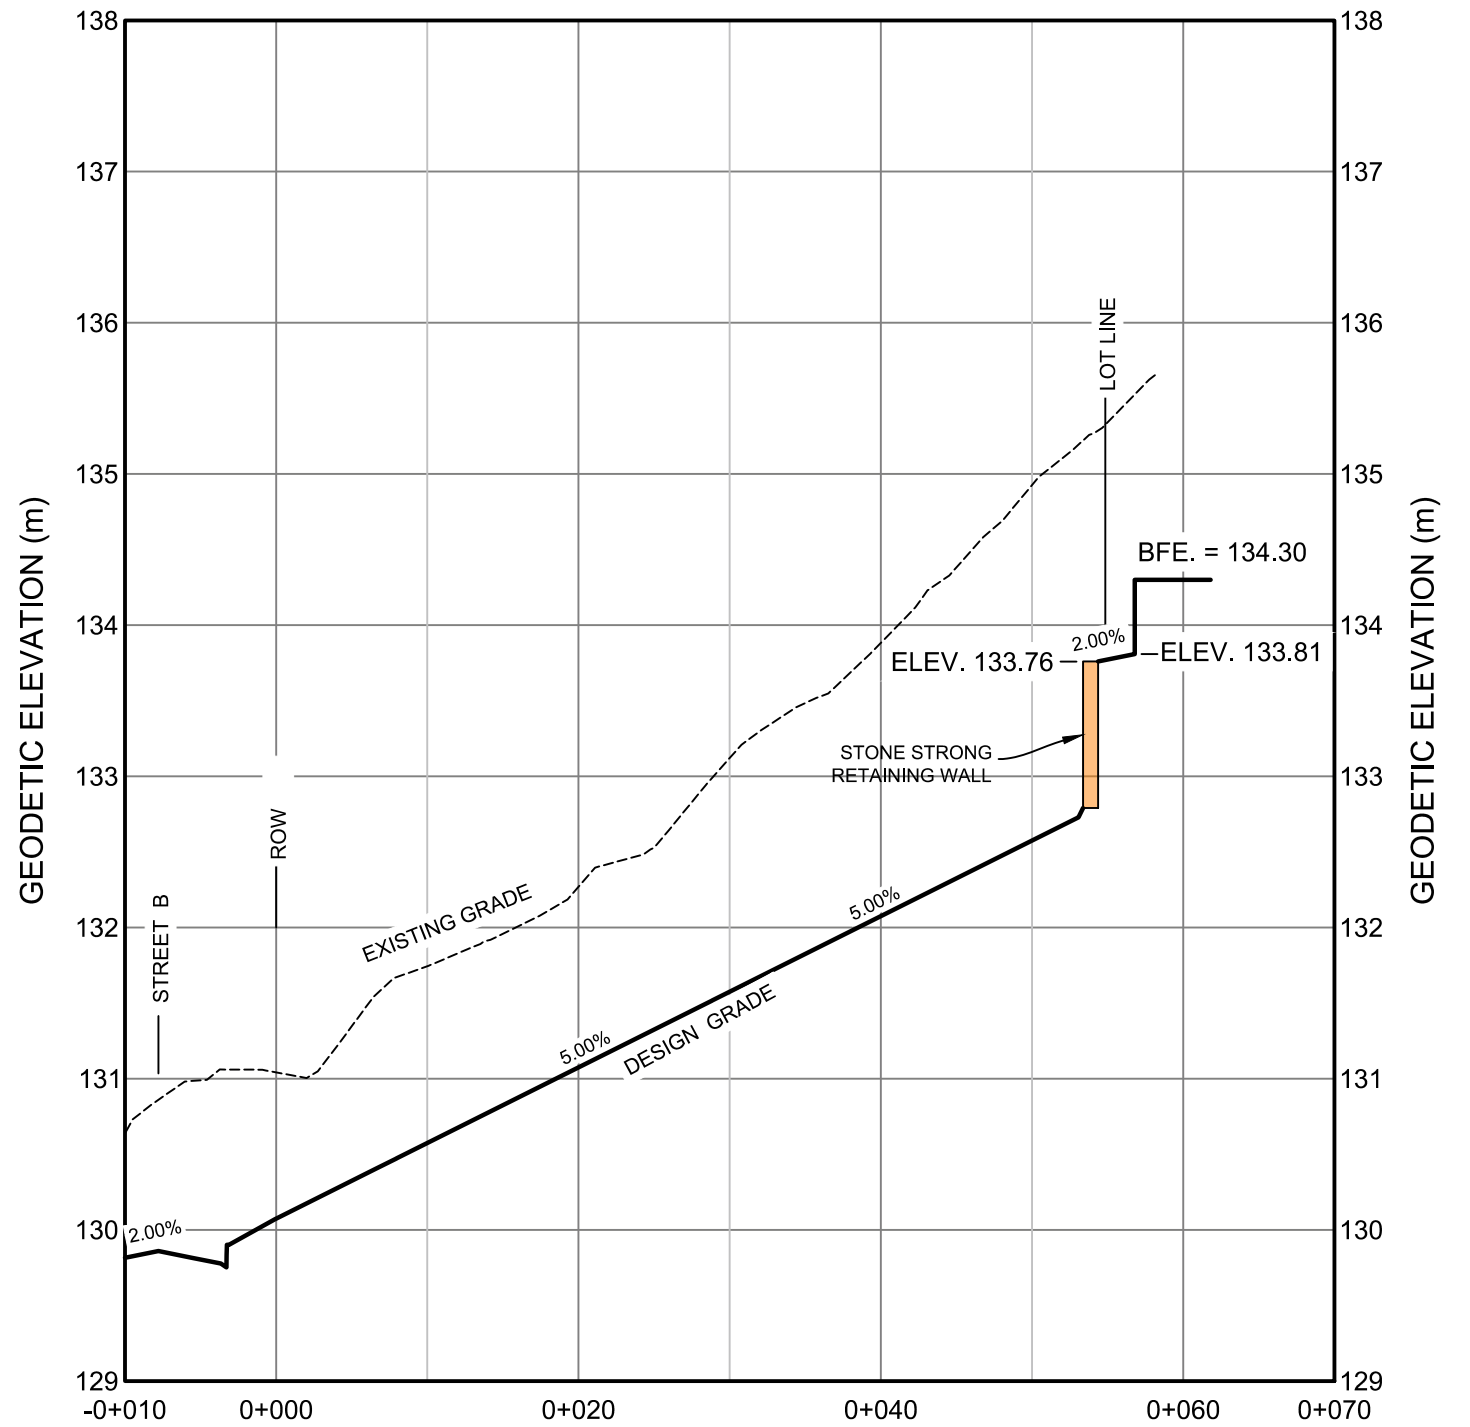
C-SK01

Filename

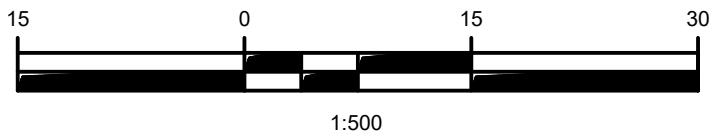
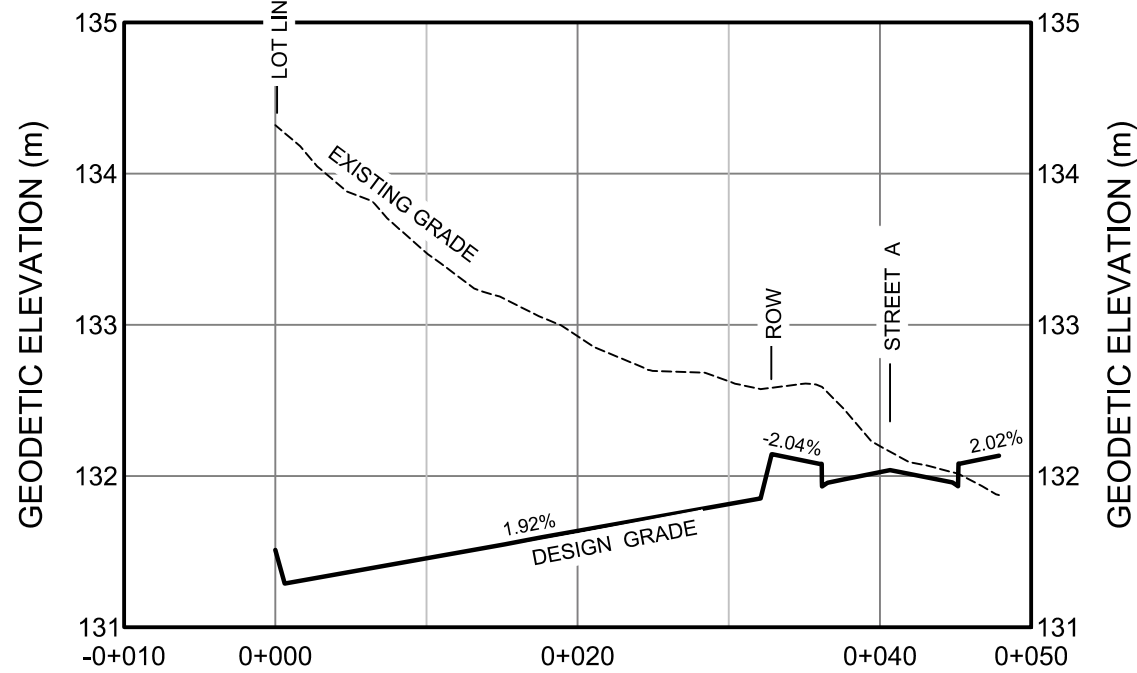
1 OF 2

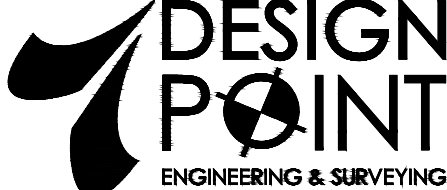

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PARK SECTION A-A Profile



PARK SECTION B-B Profile



CONSULTANT	CLIENT	PROJECT DESCRIPTION	SHEET DESCRIPTION	Engineer	Drawn
 <p>PHONE: 902.832.5597 www.designpoint.ca</p>		<p>BERRY HILLS PHASE 8</p> <p>MIDDLE SACKVILLE, NOVA SCOTIA</p>	<p>PARK GRADING SECTION A-A & B-B</p>	G. WOODFORD	E.E.H.
				Scale 1:500 HORIZ. 1:50 VERT	Date Dec. 18, 2019
				Project No. 15-082	Drawing No. C-SK02
				Filename 15-082_CP_02.dwg	2 OF 2